C&H HOG FARMS GESTATION-FARROWING FARM


AS BUILT ENGINEERING PLAN SHEETS

SECTION 26, T 15 N, R 20 W NEWTON COUNTY, ARKANSAS

DATE: APRIL 12, 2013

SHEET INDEX

SHEET 7 — SHEET 8 —	WASTE STORAGE POND FINAL DESIGN PROPOSED SITE PLAN CROSS SECTION
SHEET 10 - SHEET 11 -	WASTE STORAGE POND & BARN CROSS SECTIONS WASTE STORAGE POND CROSS SECTIONS
SHEET 13 - SHEET 14 - SHEET 15 -	POND INLET & MAXIMUM BERM DETAILS WASTE STORAGE POND 1 STAGE STORAGE TABLE WASTE STORAGE POND 2 STAGE STORAGE TABLE

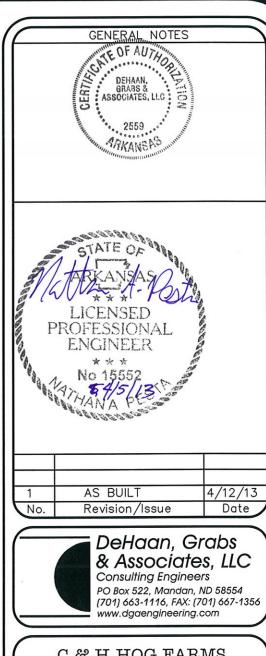



C & H HOG FARMS GESTATION-FARROWING FARM


SECTION 26, T 15 N, R 20 W NEWTON COUNTY, AR


COVER SHEET

DATE:	SHEET:
JUN 1, 2012	
SCALE: NONE	
DRAWN BY: NAP	COVER
CHECKED BY:	

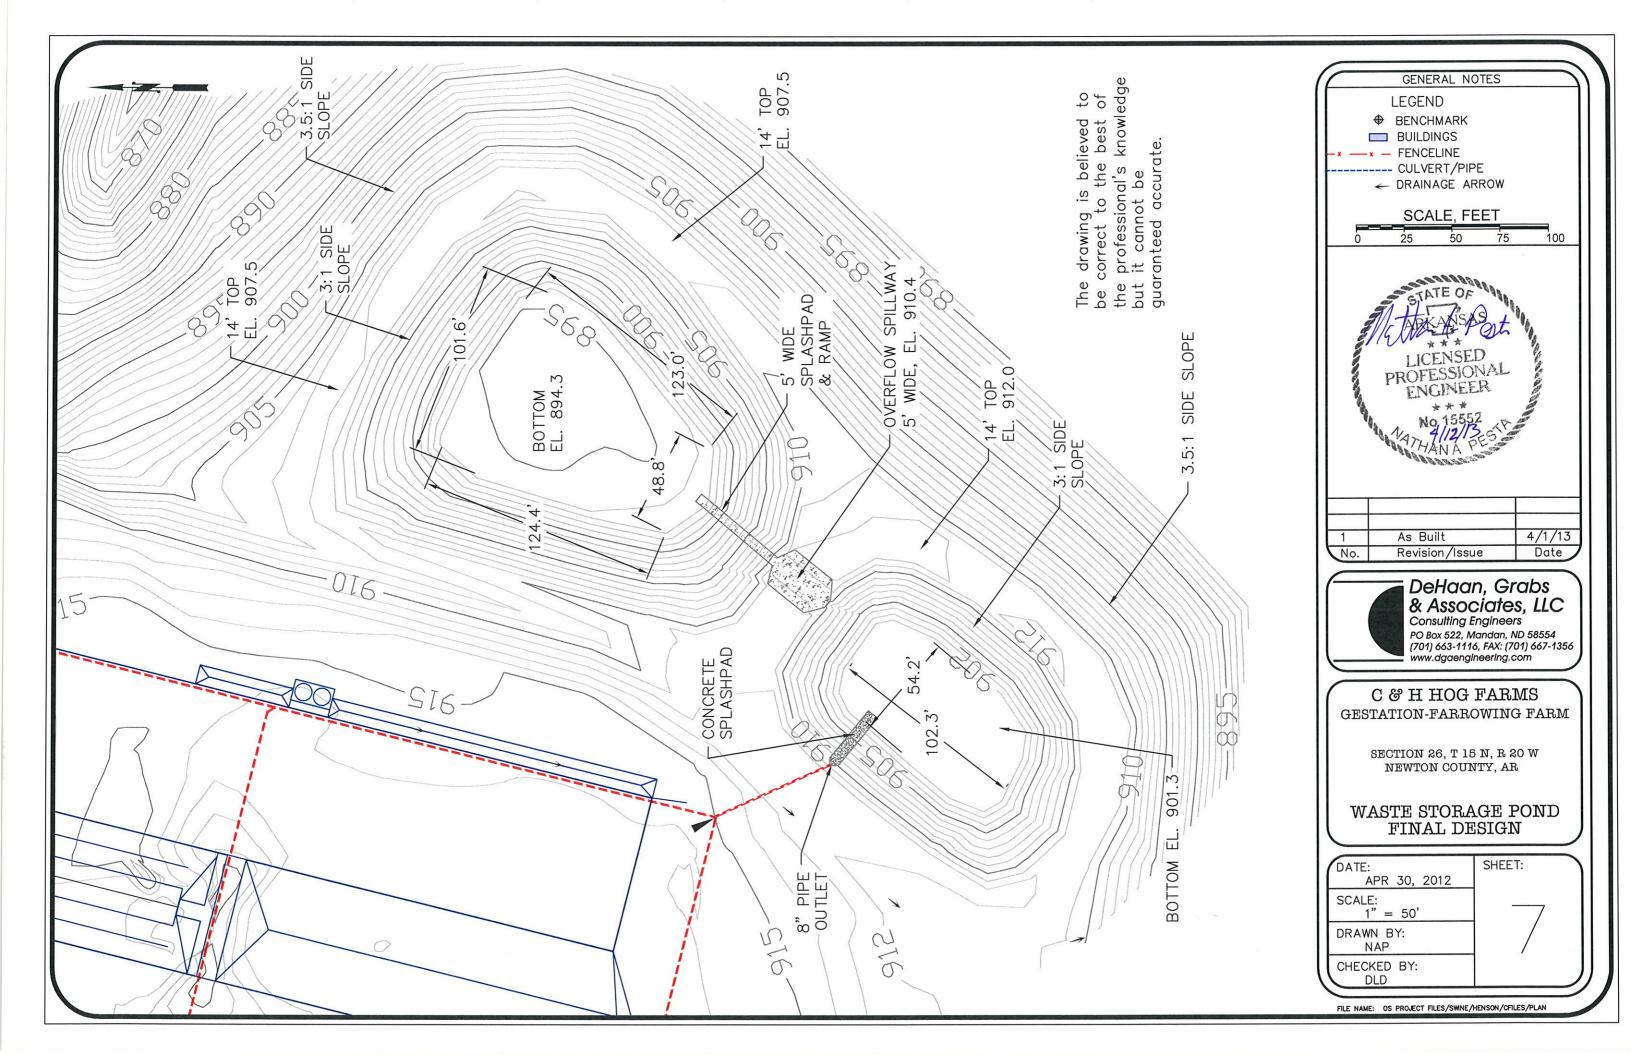


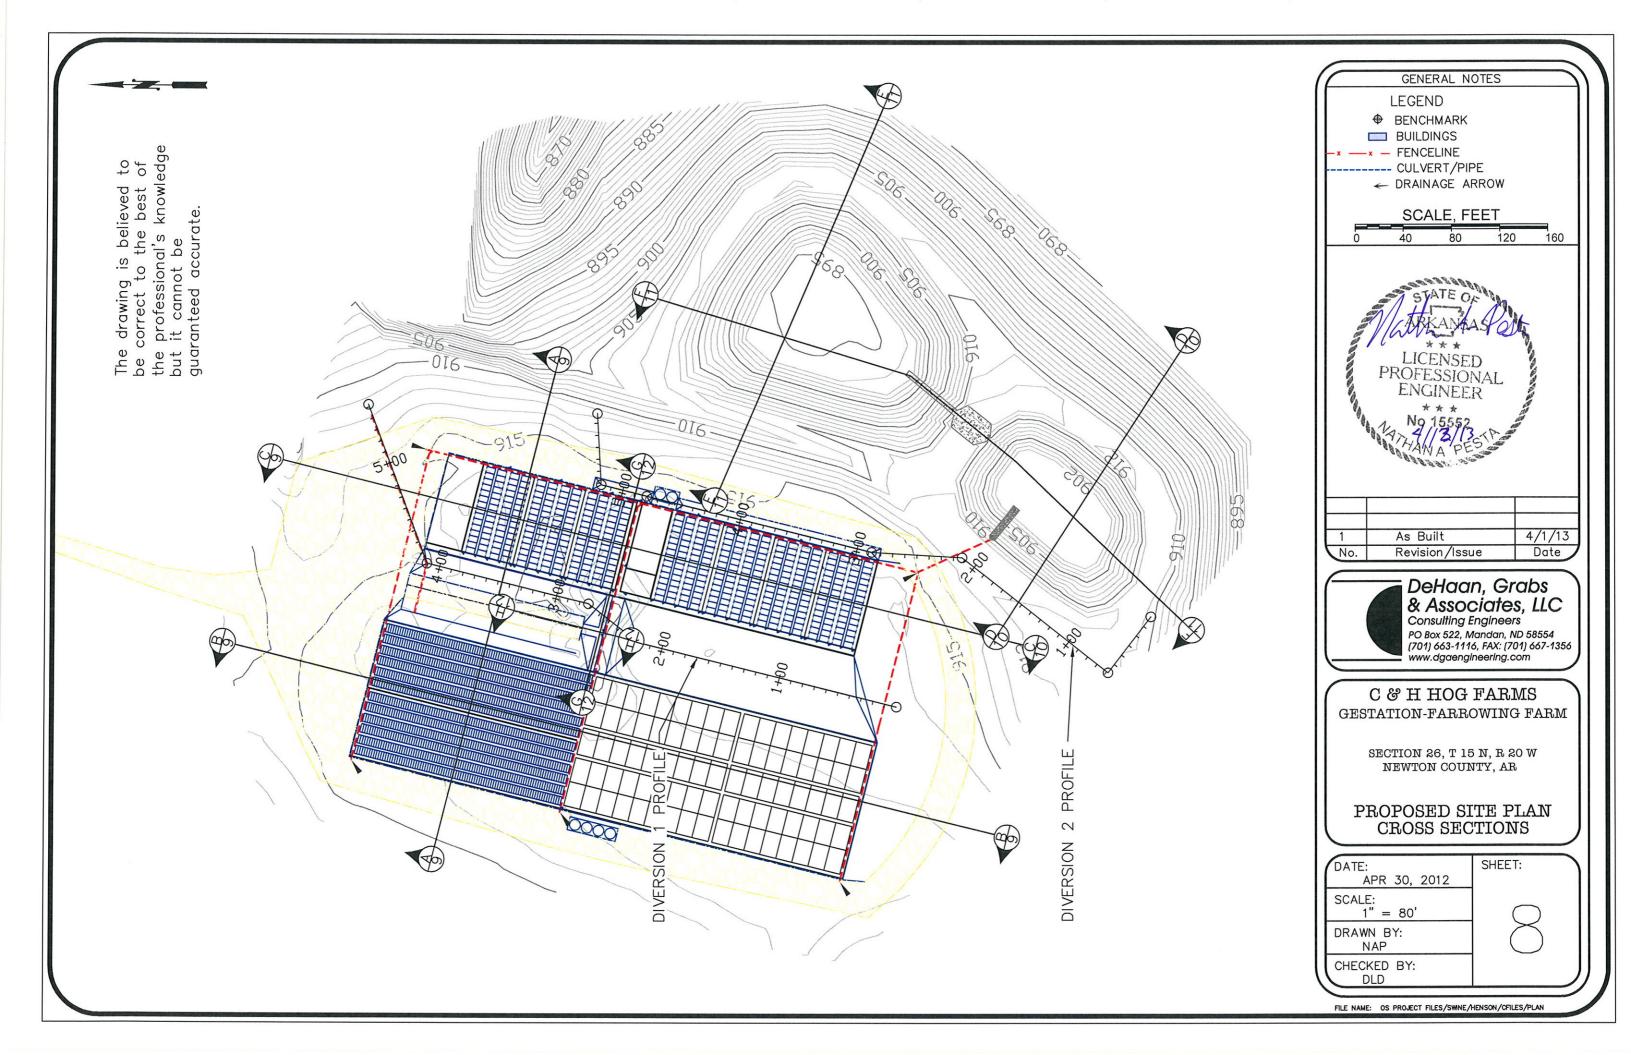

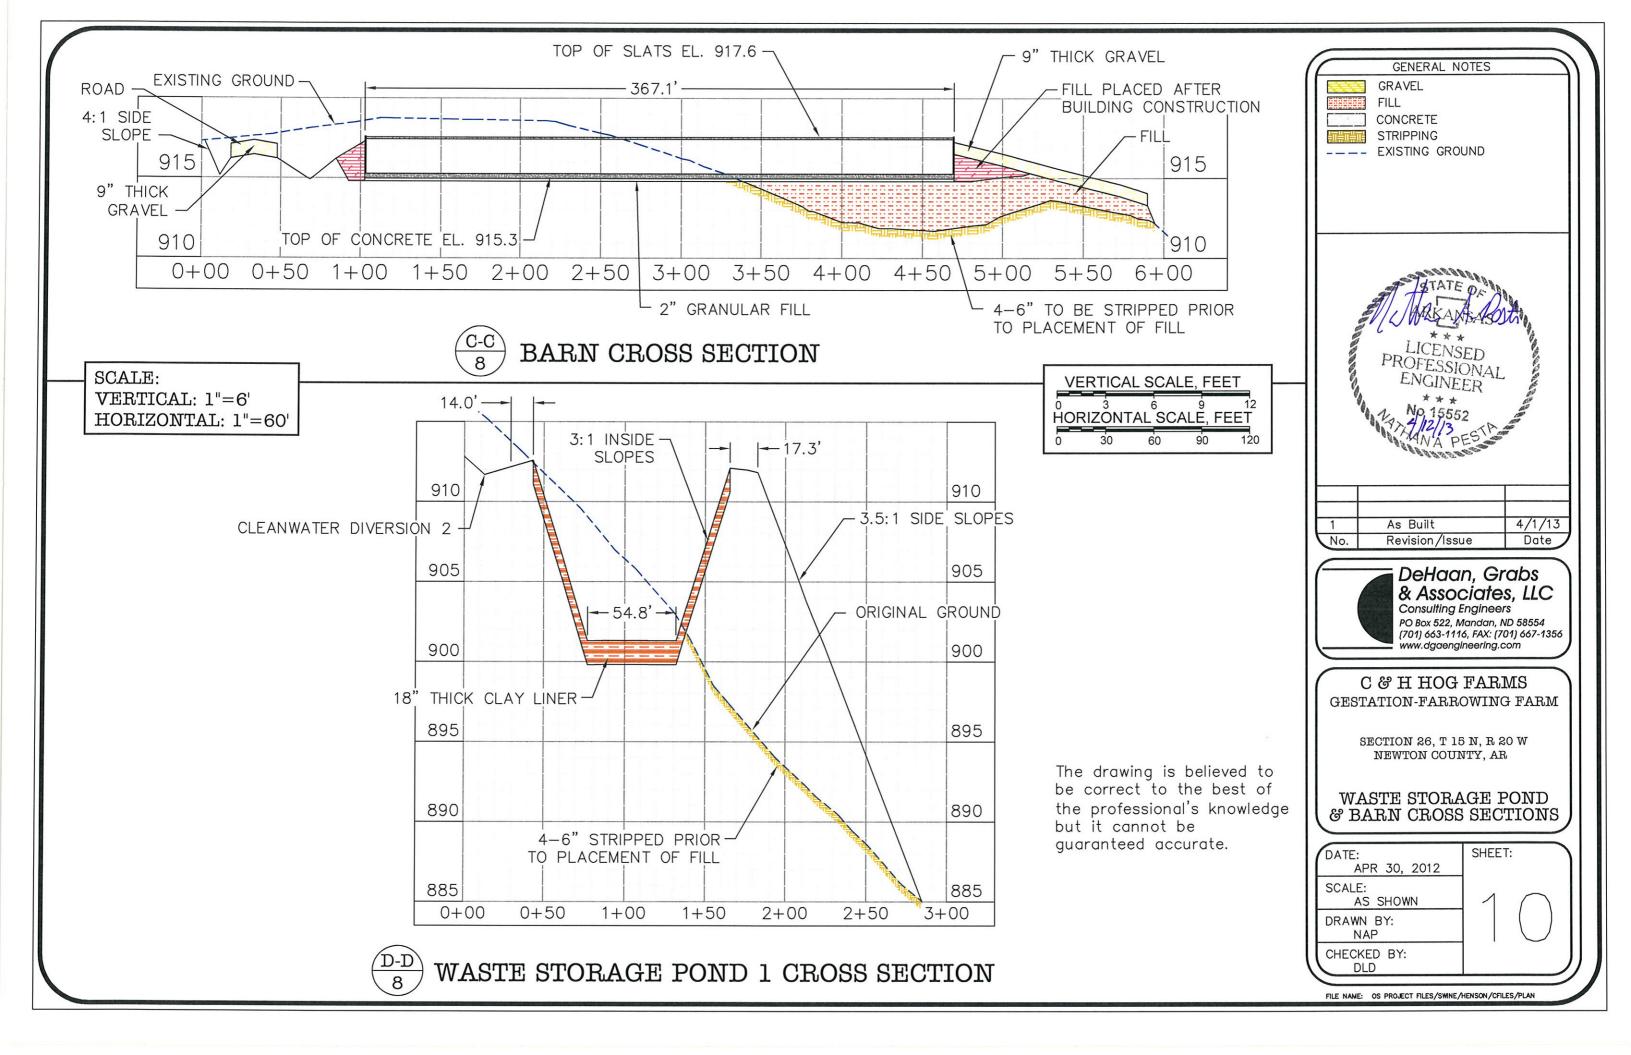

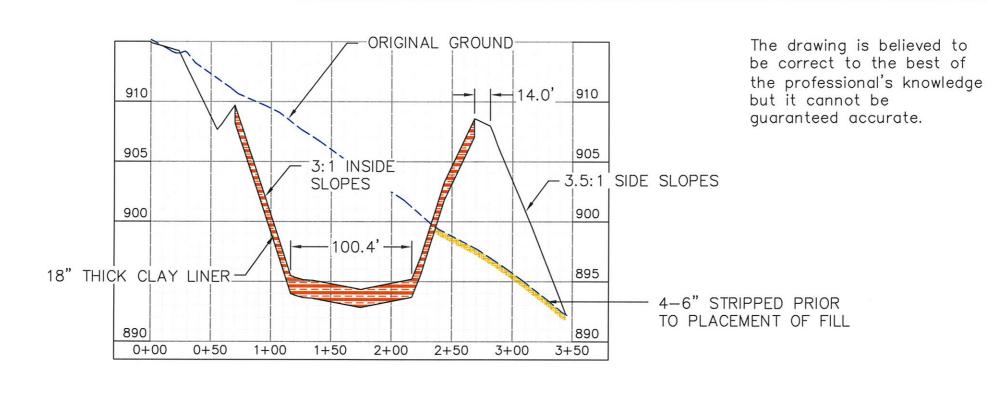



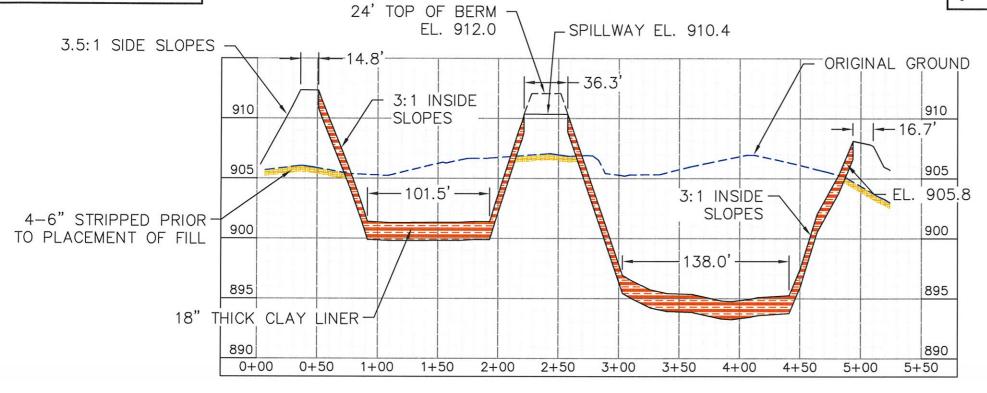

SCALE:

VERTICAL: 1"=8'

HORIZONTAL: 1"=80'

WASTE STORAGE POND 1 & 2 CROSS SECTION

GRAVEL
FILL
CONCRETE
STRIPPING
EXISTING GROUND

STATE OF

ARKANSAS

LICENSED
PROFESSIONAL
ENGINEER

No 15552

12/13
No. Revision/Issue
Date

GENERAL NOTES




Consulting Engineers
PO Box 522, Mandan, ND 58554
(701) 663-1116, FAX: (701) 667-1356
www.dgaengineering.com


C & H HOG FARMS
GESTATION-FARROWING FARM

SECTION 26, T 15 N, R 20 W NEWTON COUNTY, AR

WASTE STORAGE POND CROSS SECTIONS

DATE:	SHEET:
APR 30, 2012	
SCALE: AS SHOWN	
DRAWN BY: NAP	
CHECKED BY: DLD	

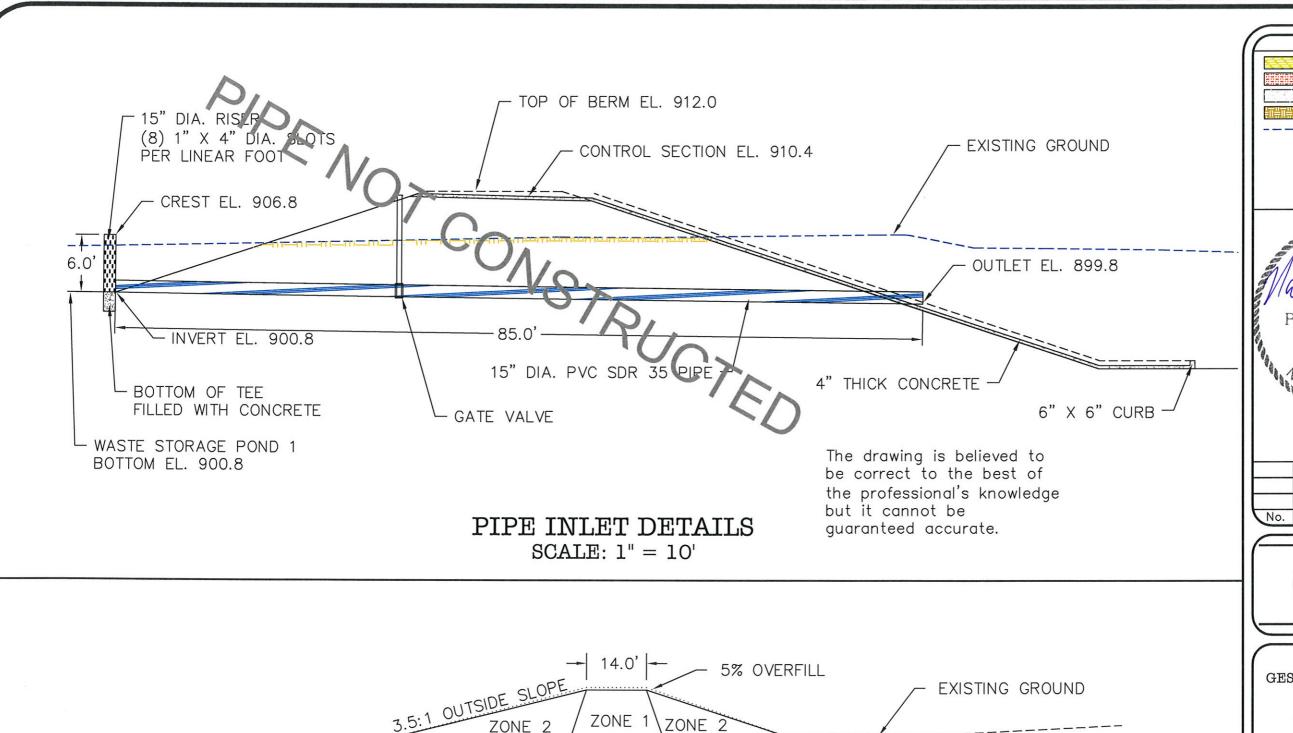

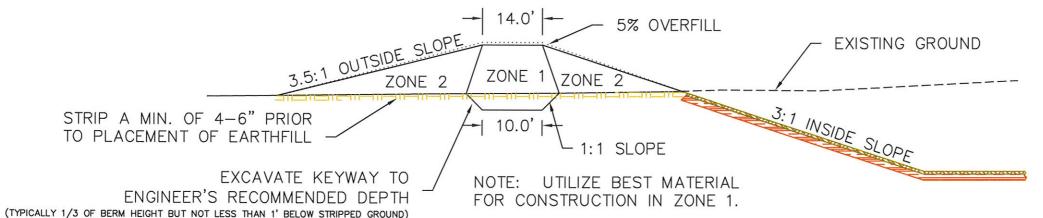

TYPICAL HOLDING POND MAXIMUM BERM DETAIL NOT TO SCALE

GENERAL NOTES GRAVEL FILL CONCRETE STRIPPING EXISTING GROUND STATE OF ARKANSAS LICENSED PROFESSIONAL ENGINEER No 15552 1974/12/13 PANA PEST



DeHaan, Grabs & Associates, LLC

Consulting Engineers
PO Box 522, Mandan, ND 58554
(701) 663-1116, FAX: (701) 667-1356
www.dgaengineering.com

C & H HOG FARMS
GESTATION-FARROWING FARM


SECTION 26, T 15 N, R 20 W NEWTON COUNTY, AR

POND INLET & MAXIMUM BERM DETAILS


DATE:	SHEET:
APR 30, 2012 SCALE: AS SHOWN	1 7
DRAWN BY: NAP	
CHECKED BY: DLD	

The drawing is believed to be correct to the best of the professional's knowledge but it cannot be guaranteed accurate.

Waste Storage Pond 1 Stage Storage Table						
		Cum. Volume	Volume	Area	Stage	Elevation
	(acre-feet)	(ft ³)	(ft ³)	(ft ²)	(ft)	(ft)
Тор		118,918	28,793	20,153	10.7	912.0
Freeboard	2.3	100,065	19,227	17,130	9.7	911.0
25 Year-24 Hour Stage/Overflow El	2.1	90,125	16,603	15,838	9.1	910.4
	1.9	80,838	7,316	14,915	8.5	909.8
	1.7	73,522	6,946	14,349	8.0	909.3
	1.5	66,576	6,585	13,435	7.5	908.8
	1.4	59,991	6,235	12,905	7.0	908.3
	1.2	53,756	5,898	12,035	6.5	907.8
180 Day Stage	1.1	47,858	5,570	11,557	6.0	907.3
	1.0	42,288	5,253	10,723	5.5	906.8
	0.9	37,035	4,947	10,289	5.0	906.3
	0.7	32,088	4,648	9,499	4.5	905.8
	0.6	27,440	4,360	9,093	4.0	905.3
	0.5	23,080	4,079	8,347	3.5	904.8
The state of the s	0.4	19,001	3,808	7,969	3.0	904.3
	0.3	15,193	3,524	7,263	2.5	903.8
No. of the latest states and the latest stat	0.3	11,669	3,294	6,833	2.0	903.3
	0.2	8,375	3,060	6,343	1.5	902.8
	0.1	5,315	2,837	5,897	1.0	902.3
Sludge El.	0.1	2,478	2,478	5,451	0.5	901.8
Bottom		0	0	0	0.0	901.3

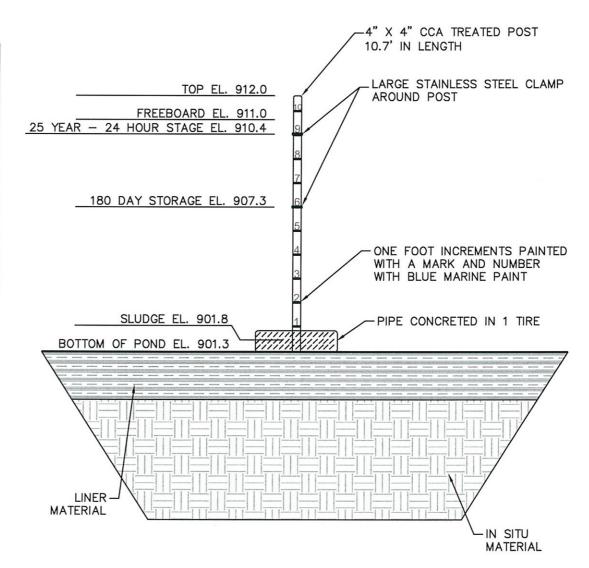

WASTE STORAGE POND 1

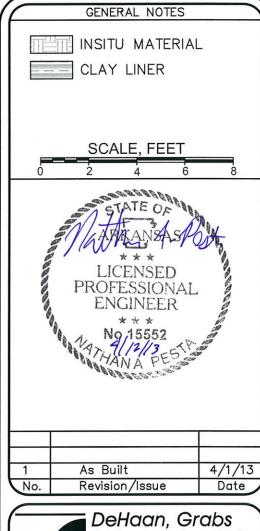



DeHaan, Grabs & Associates, LLC Consulting Engineers

Consulting Engineers PO Box 522, Mandan, ND 58554 (701) 663-1116, FAX: (701) 667-1356 www.dgaengineering.com

C & H HOG FARMS GESTATION-FARROWING FARM

> SECTION 26, T 15 N, R 20 W NEWTON COUNTY, AR

WASTE STORAGE POND 1 STAGE STORAGE TABLE

DATE:

MAY 30, 2012

SCALE:

1" = 4'


DRAWN BY:

CAS


CHECKED BY:

Elevation	Stage	Area	Volume	nd 2 Stage	Cum. Volume	
(ft)	(ft)	(ft²)	(ft ³)	(ft ³)	(acre-feet)	
907.5	13.2	32,950	16,166	246,200	5.7	Тор
907.0	12.7	31,714	15,536	230,034	5.3	ТОР
906.5	12.2	30,430	17,828	214,498	4.9	Freeboard
000.0	12.2	00,400	17,020	214,430	4.9	
905.9	11.6	28,996	16,963	196,670	4.5	25 Year-24 Hour Stage/Must Pumpdowr
905.3	11.0	27,547	13,488	179,707	4.1	Ctage/Must r umpuowi
904.8	10.5	26,405	12,914	166,219	3.8	
904.3	10.0	25,251	12,353	153,305	3.5	
903.8	9.5	24,161	11,805	140,952	3.2	
903.3	9.0	23,059	11,270	129,147	3.0	
902.8	8.5	22,021	10,755	117,877	2.7	
902.3	8.0	20,999	10,261	107,122	2.5	
901.8	7.5	20,045	9,786	96,861	2.2	
901.3	7.0	19,099	9,332	87,075	2.0	
900.8	6.5	18,229	8,894	77,743	1.8	
900.3	6.0	17,347	8,467	68,849	1.6	
899.8	5.5	16,521	8,049	60,382	1.4	
899.3	5.0	15,675	7,640	52,333	1.2	
898.8	4.5	14,885	7,239	44,693	1.0	
898.3	4.0	14,071	6,848	37,454	0.9	
897.8	3.5	13,321	6,464	30,606	0.7	
897.3	3.0	12,535	6,088	24,142	0.6	
896.8	2.5	11,817	5,638	18,054	0.4	
896.3	2.0	10,735	5,060	12,416	0.3	
895.8	1.5	9,505	4,240	7,356	0.2	
895.3	1.0	7,455	2,565	3,116	0.1	180 Day Stage
894.8	0.5	2,805	551	551	0.0	
894.3	0.0	0	0	0	0.0	Bottom

The drawing is believed to be correct to the best of the professional's knowledge but it cannot be guaranteed accurate.

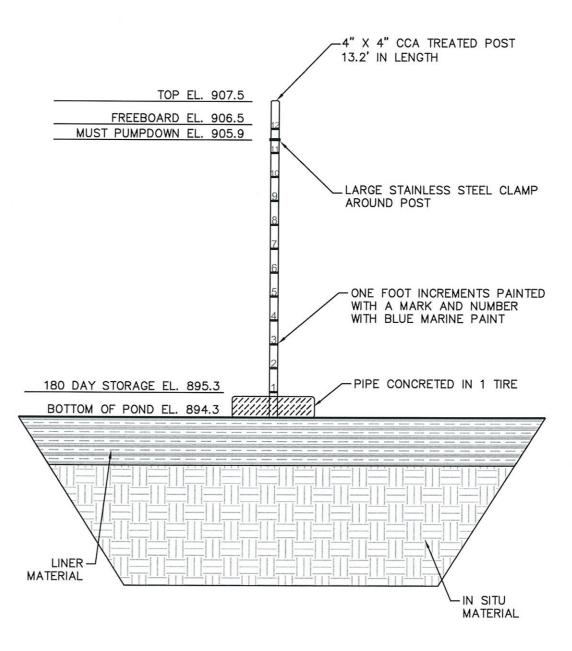

WASTE STORAGE POND 2

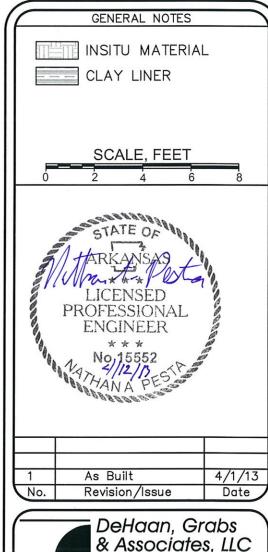



& Associates, LLC Consulting Engineers PO Box 522, Mandan, ND 58554 (701) 663-1116, FAX: (701) 667-1356 www.dgaengineering.com

C & H HOG FARMS GESTATION-FARROWING FARM

> SECTION 26, T 15 N, R 20 W NEWTON COUNTY, AR

WASTE STORAGE POND 2 STAGE STORAGE TABLE

SHEET: MAY 30, 2012 SCALE: 1" = 4' DRAWN BY: CAS CHECKED BY: DLD

Gage, Hannah

From: Hogan, Stephen

Sent: Wednesday, April 17, 2013 8:18 AM

To: Deardoff, Amy **Subject:** FW: 2-2

Attachments: 20130416084545.pdf

Amy,

Please add this to zylab and the web. ARG590001. This only difference between this one and the previous one is this one has Sheet No. 15. Handle however you need to.

Thanks,

Stephen

From: Nathan Pesta [mailto:Nathanpdga@btinet.net]

Sent: Tuesday, April 16, 2013 8:34 AM

To: Hogan, Stephen

Cc: 'Jason Henson'; 'Richard Gray'

Subject: RE: 2-2

Stephen,

Sorry, I was out yesterday we got 18" of snow on Sunday and they didn't get our office road opened up till late afternoon yesterday. The scanner must have grabbed 14 and 15 together.

Nathan

From: Hogan, Stephen [mailto:HOGAN@adeq.state.ar.us]

Sent: Monday, April 15, 2013 10:04 AM

To: Nathan Pesta Subject: RE: 2-2

Nathan,

I seem to be missing Sheet 15. Email this to me as soon as possible.

If you have any questions, please let me know.

Thanks,

Stephen Hogan, P.E. (501) 682-0651

From: Nathan Pesta [mailto:Nathanpdga@btinet.net]

Sent: Friday, April 12, 2013 10:29 AM

To: Hogan, Stephen

Cc: 'Jason Henson'; 'Richard Gray'; 'Patrick Pollack'

Subject: 2-2

Nathan A.Pesta P.E. Senior Project Engineer DeHaan, Grabs and Associates, LLC Bus 701-663-1116 Cell 701-400-3950 Fax 701-667-1356 www.dgaengineering.com